

SEE OPERATION MANUAL: IB01602009E or IB01602001R


GIC CHANNEL

HOSE TEST HEADER HAS BEEN ADDED TO THE DISCHARGE HEADER

MODIFICATIONS TO PLANS, ADDED CALCULATION TO OVERHEAD PIPING.

MODIFIED PAINT BOOTH CALCULATION DUE TO FPE REVIEW AND PLAN

BASE PLATE 10MM

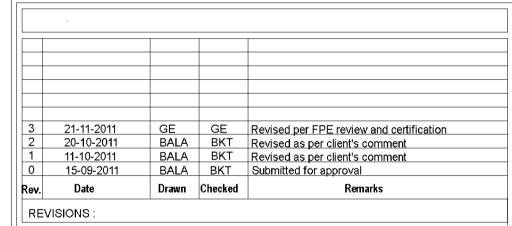

PROJECT NAME

FIRE PROTECTION SYSTEM FOR CORROSIION REPAIR BUILDINGS

PROJECT OWNER:

USACE


MAIN CONTRACTOR:

STRABAG OMAN LLC

STRABAG Oman LLC PO Box 444, Muscat Postal Code 100 Sultanate of Oman Tel.: +968-24526900 Fax: +968-24526902

FIRE PROTECTION SYSTEM CONTRACTOR:

PROTECT UNITED TRADING & CONT. CO PB. NO. 2934. POSTAL CODE -211, SALALAH, SULTANALE OF OMAN TEL.: +968 23210925 FAX.: +968 23210926 Email:protectu@mail.com

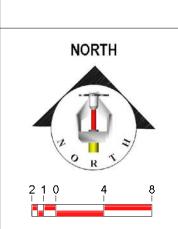

PIPE SUPPORT SPACING AND DIMENSION SHALL BE ACCORDING TO THE SITE CONDITION Standard Symbols -II--P.I.V. - Post Indicator Valve —■ N.R.S. - Key Operated Valve - Public Hydrant FDC - Fire Dept. Connection - O.S.&Y. Gate Valve Check Valve New Underground

GROOVED FITTINGS SHALL BE UL LISTED AND FM APPROVED DUCTILE IRON FITTINGS

Existing Underground

THREADED FITTINGS SHALL BE UL LISTED FM APPROVED MALLEABLE IRON GALVANIZED FITTINGS.

PRESSURE SENSING LINE TO CONTROL PANELS SHALL BE ROUTED TO SUIT THE SPACE AVAILABILITY

Standard Symbols - Alarm Check Valve - Thrust Block - Backflow Preventer

PAINTING FOR THE EXTERNAL PIPING AND FABRICATED SUPPORTS SHALL BE DONE WITH ZINC RICH EPOXY BASED PRIMER AND TOP COAT.

10 -20 MM GROUTING ALLOWANCE SHALL BE PROVIDED BETWEEN PUMP FOUNDATION AND THE BASE FRAME FOR ELECTRIC PUMPS

Standard Sprinkler Symbols - Upright on 1/2" Outlet - Pendent on 1/2" Outlet -O- - Upright on 1" Sprig - Pendent below ceiling on 1" Drop

- Sidewall on 1" Sprig

THE STEEL PIPES SHALL BE ASTM A53 GRADE B- SCHEDULE 40 ERW PIPES & BURIED SECTION OF PIPE SHALL BE DUCTILE IRON PIPING WITH SOCKET & SPIGOT JOINTS.

GENERAL SYSTEM NOTES 1. HYDRAULIC INFORMATION TO BE PROVIDED ON SPRINKLER RISER. 2. EARTHQUAKE BRACING TO BE PROVIDED PER NFPA 13, IF REQUIRED 3. ALL INSPECTORS' TEST CONNECTIONS AND LOW POINT DRAINS TO BE PROVIDED PER NFPA 13. 4. ALL HANGERS TO MEET CURRENT NFPA 13 REQUIRMENTS (U.N.O.). 5. LINE PIPING SHALL BE SCH. #40 GALVANIZED PIPE WITH WELDED OUTLETS, ROLL GROOVED/THREADED ENDS WITH GROOVED/THREADED FITTINGS. 6. MAIN PIPING SHALL BE SCH. #40 GALVANIZED WITH - Upright above Pendent on 1" Drop WELDED OUTLETS, ROLL GROOVED ENDS, AND GROOVED FITTINGS. - Sidewall on 1/2" Outlet 7. SYSTEM DESIGN SHALL BE PER N.F.P.A. #13

10. ALL SYSTEM COMPONENTS SHALL BE U.L. LISTED AND F.M. APPROVED.

11. SPARE HEAD CABINET TO INCLUDE: (2) ADD HEADS EA KIND, WRENCH & COPY OF NFPA 25

8.XXX = HYDRAULIC REFRENCE POINT.

Sprinkler Legend Symbol|Manufacturer |SIN/Model|Quantity |K-Factor |Type |Response |Orifice|Finish|Temperature O | Rapidrop RD025 80 Upright Quick 12 1/2 Brass 93.33 ℃ Rapidrop RD023 80 Pendent Quick

REVIEW COMMENTS.

REV -2


REV-3



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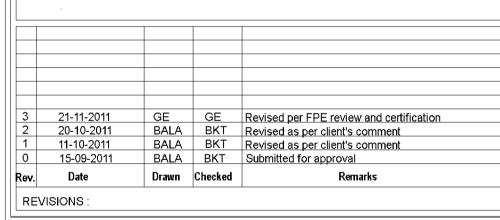
DRAWING TITLE: FP01 GWE CHECKED Gerald W. Ebeling, S.E.T. 11/23/11 APRROVED GWE AS NOTED REV. NO. SCALE DRAWING NO.:FIRE PUMP ROOM LAYOUT SHEET:1 OF 6

FIREWATER TANK SHALL BE GRP SECTIONAL BOLTED TYPE TANKS OF SIZE 8000 X 5000 X 3000 OF A CAPACITY OF 120 M CU. PIPE SUPPORT SPACING AND DIMENSION SHALL BE ACCORDING TO THE SITE CONDITION

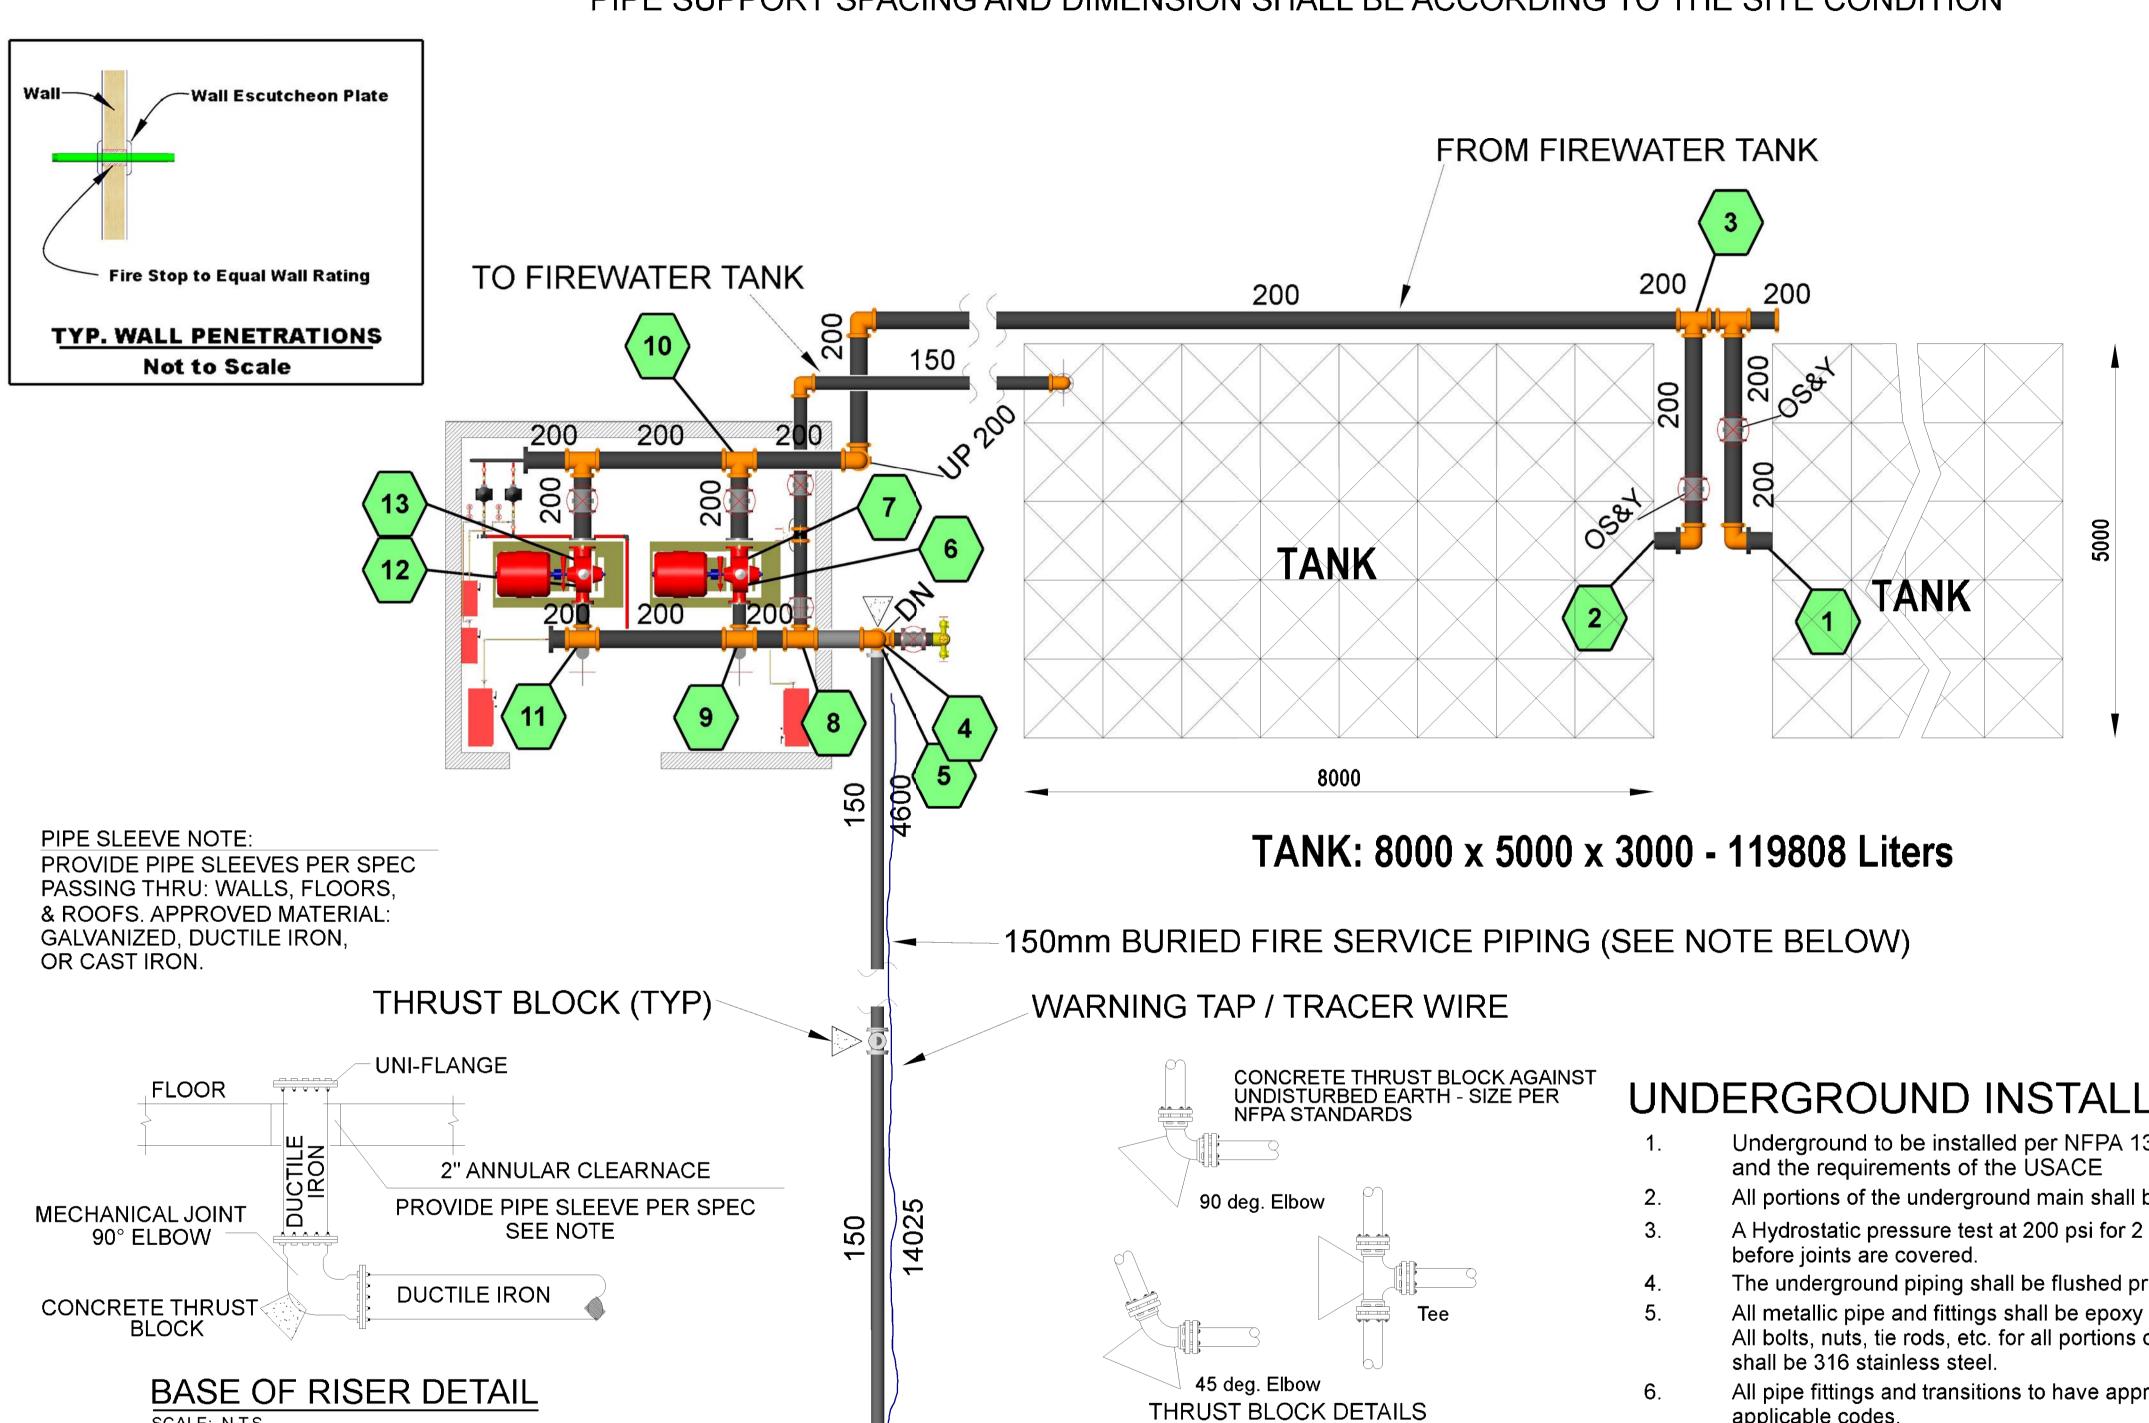

UNDERGROUND INSTALLATION NOTES

- Underground to be installed per NFPA 13, 2010, NFPA 24, 2010
- All portions of the underground main shall be DUCTILE IRON.
- A Hydrostatic pressure test at 200 psi for 2 hours shall be conducted
- The underground piping shall be flushed prior to system tie in.
- All metallic pipe and fittings shall be epoxy coated, polyethylene encased. All bolts, nuts, tie rods, etc. for all portions of the underground mains
- All pipe fittings and transitions to have approved thrust blocks meeting all applicable codes.
- Pipe and fittings to be Class 51 minimum and to be UL listed for fire service.
- Minimum pipe bury to be 42".
- Provide a 2" annular clearance around pipe and floor slab at the system riser.
- Underground to be mechanical joint and/or thrust blocked
- Coordinate conduit run for tamper switches and/or alarms with General Contractor.
- Provide warning tape and tracer wire.



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Standard Symbols -II--P.I.V. - Post Indicator Valve —■ N.R.S. - Key Operated Valve - Public Hydrant FDC Check Valve - New Underground

SCALE: N.T.S.

- Fire Dept. Connection - O.S.&Y. Gate Valve

Existing Underground

Standard Symbols - Thrust Block - Backflow Preventer

Standard Sprinkler Symbols - Upright on 1/2" Outlet - Pendent on 1/2" Outlet -O- - Upright on 1" Sprig - Pendent below ceiling on 1" Drop - Sidewall on 1/2" Outlet

- Sidewall on 1" Sprig

DRAINS TO BE PROVIDED PER NFPA 13. - Upright above Pendent on 1" Drop

150

GENERAL SYSTEM NOTES 1. HYDRAULIC INFORMATION TO BE PROVIDED ON SPRINKLER RISER. 2. EARTHQUAKE BRACING TO BE PROVIDED PER NFPA 13, IF REQUIRED 3. ALL INSPECTORS' TEST CONNECTIONS AND LOW POINT 4. ALL HANGERS TO MEET CURRENT NFPA 13 REQUIRMENTS (U.N.O.). 5. LINE PIPING SHALL BE SCH. #40 GALVANIZED PIPE WITH WELDED OUTLETS, ROLL GROOVED/THREADED ENDS WITH GROOVED/THREADED FITTINGS. 6. MAIN PIPING SHALL BE SCH. #40 GALVANIZED WITH WELDED OUTLETS, ROLL GROOVED ENDS, AND GROOVED FITTINGS.

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10. ALL SYSTEM COMPONENTS SHALL BE U.L. LISTED AND F.M. APPROVED.

7. SYSTEM DESIGN SHALL BE PER N.F.P.A. #13 8.XXX = HYDRAULIC REFRENCE POINT.

against undisturbed soil.

thick polyethylene sheet and tape wrap

SCALE: N.T.S.

installation by FIRE PROTECTION SPECIALIST.

1. INSPECTION: Prior to backfilling around thrust block, secure inspection of

2. BACKFILL: Install and compact all backfill material per APWA SECTION 02320.

3. CONCRETE: Class 2,000 minimum per APWA Section 03304. Pour concrete


5. GREASE: Apply poly-fm grease to all buried metal surfaces. Wrap with 8 mil


4. PIPE JOINTS: DO NOT COVER WITH CONCRETE. Leave completely


Sprinkler Legend Symbol Manufacturer | SIN/Model Quantity | K-Factor | Type | Response | Orifice | Finish | Temperature O Rapidrop 12 1/2 Brass 93.33 & RD025 80 Upright Quick Rapidrop 80 Pendent Quick 13 1/2 Brass | 93.33 රි RD023





DRAWING TITLE FP2 Gerald W. Ebeling, S.E.T. CHECKED GWE 11/23/11 APRROVED GWE AS NOTED REV. NO. SCALE SHEET:2 OF 6 DRAWING NO.:PUMP ROOM AND TANK LAYOU

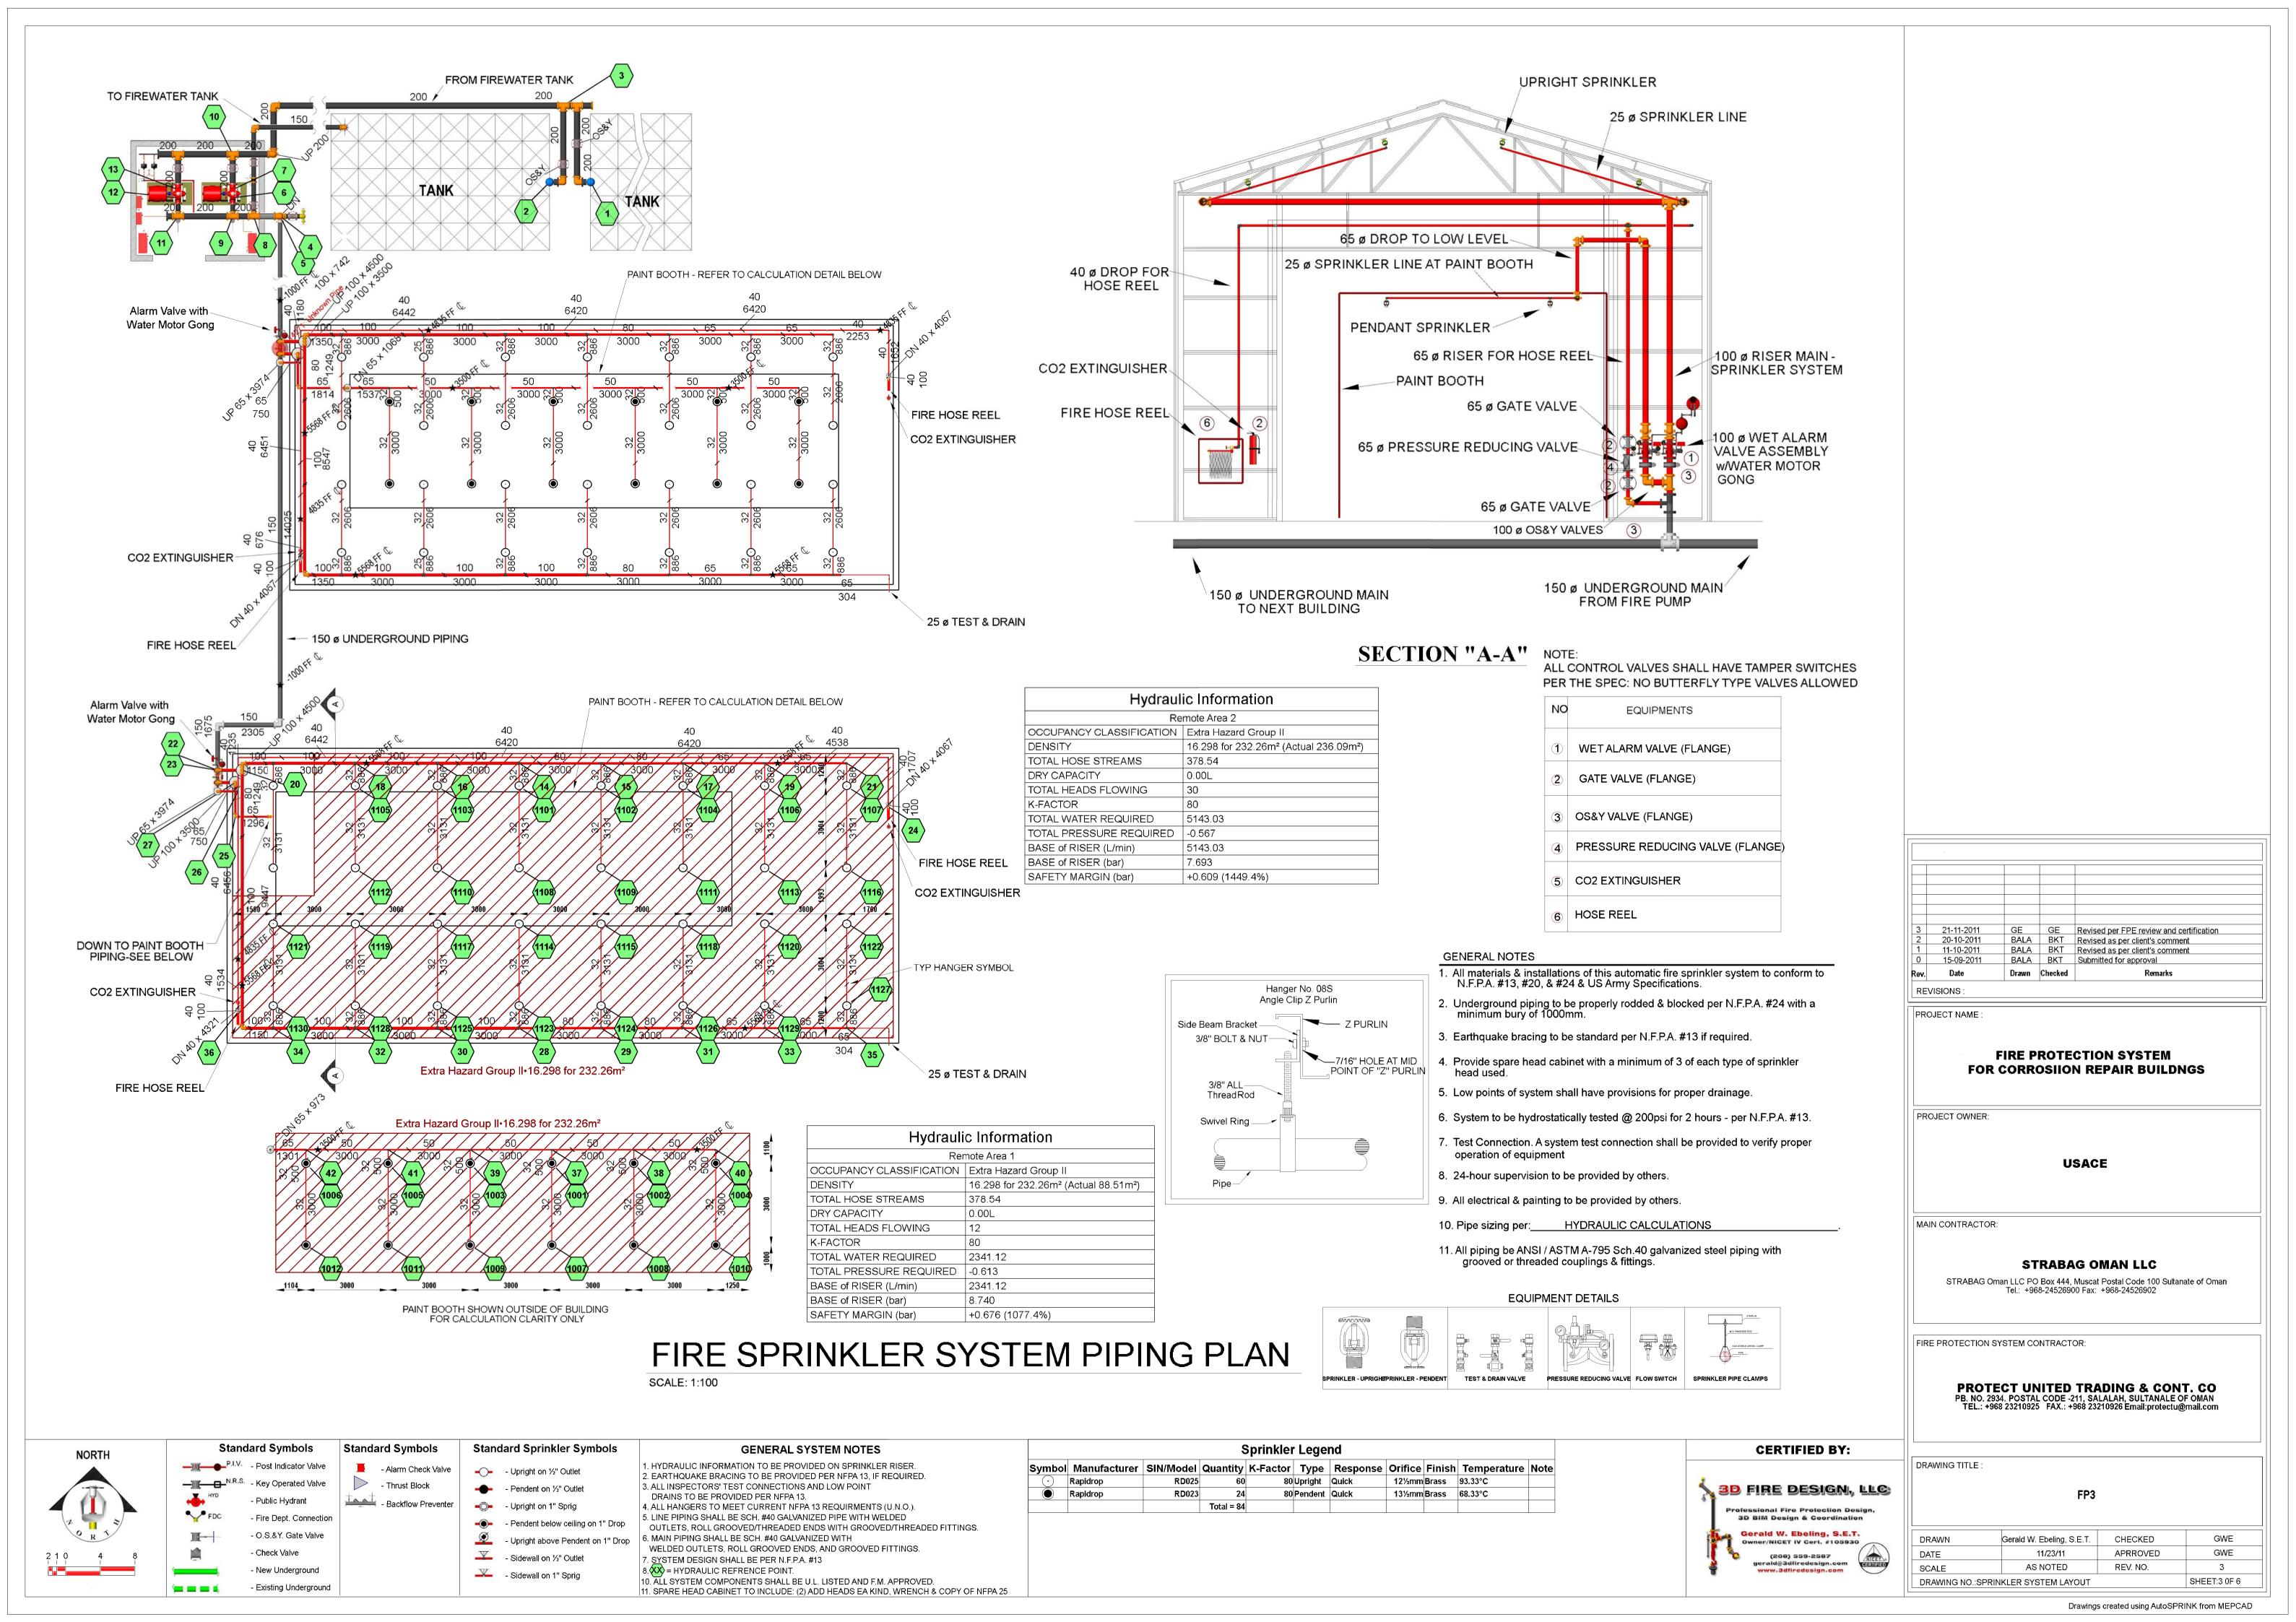

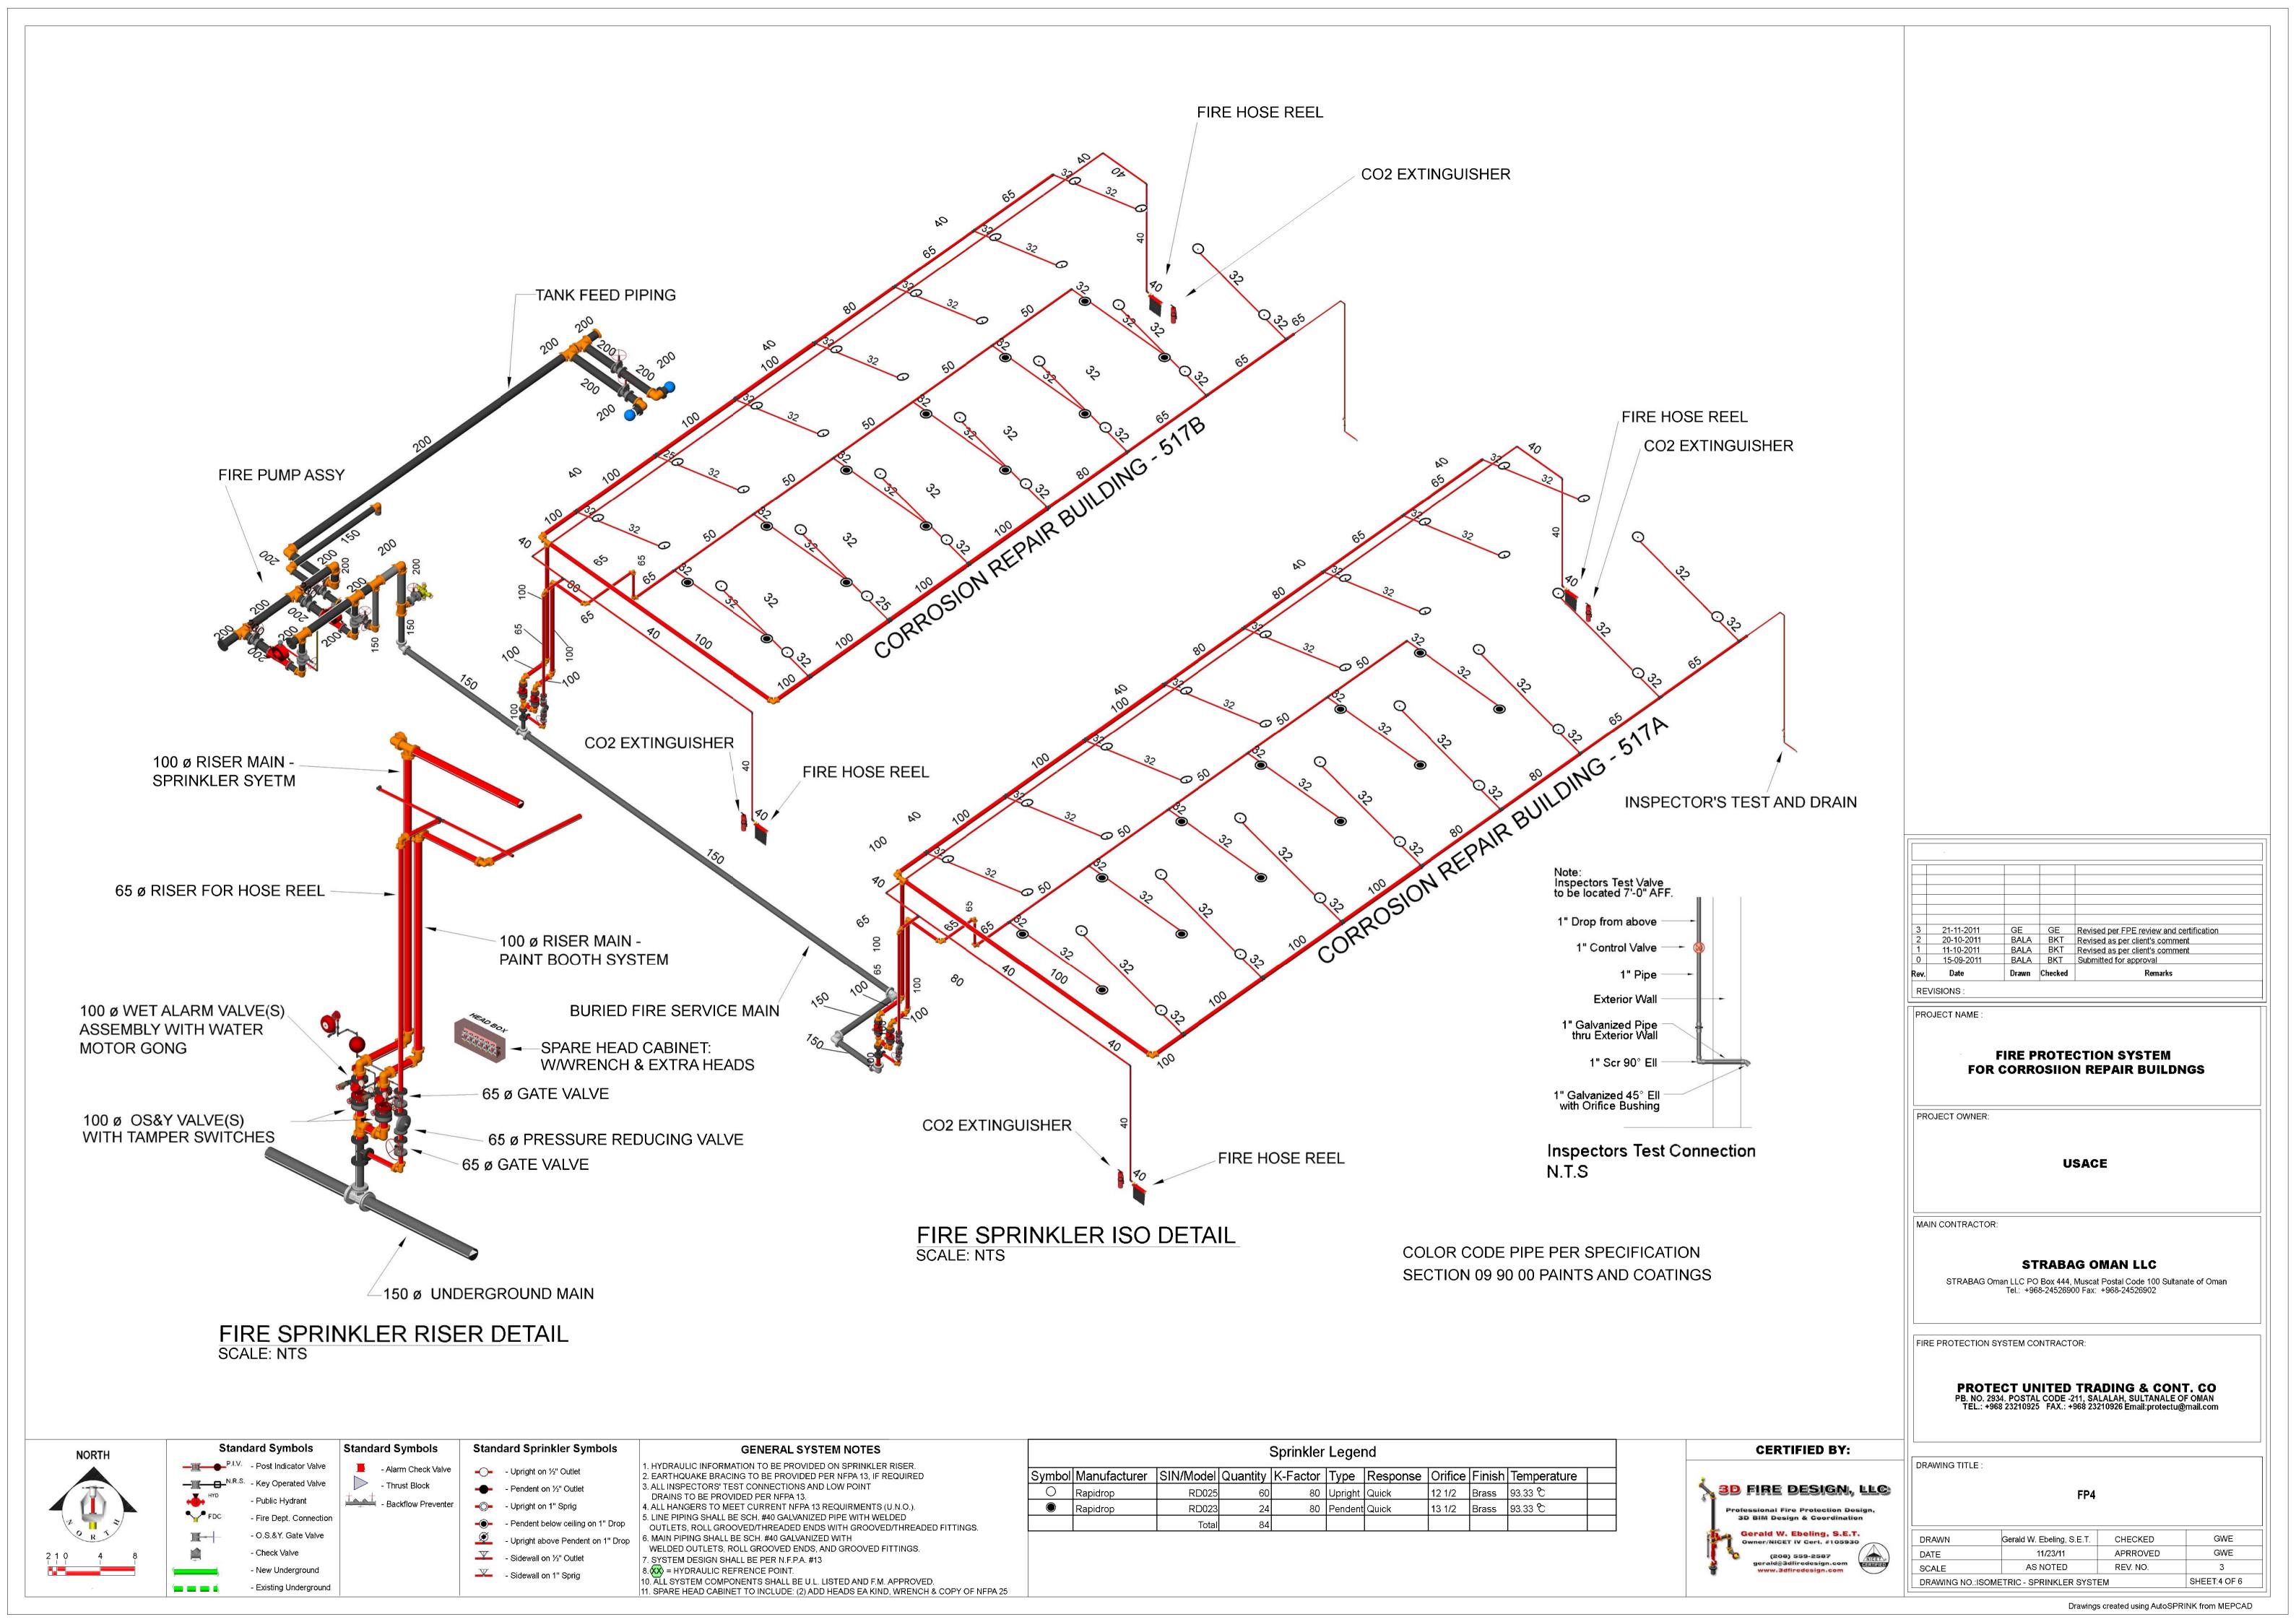

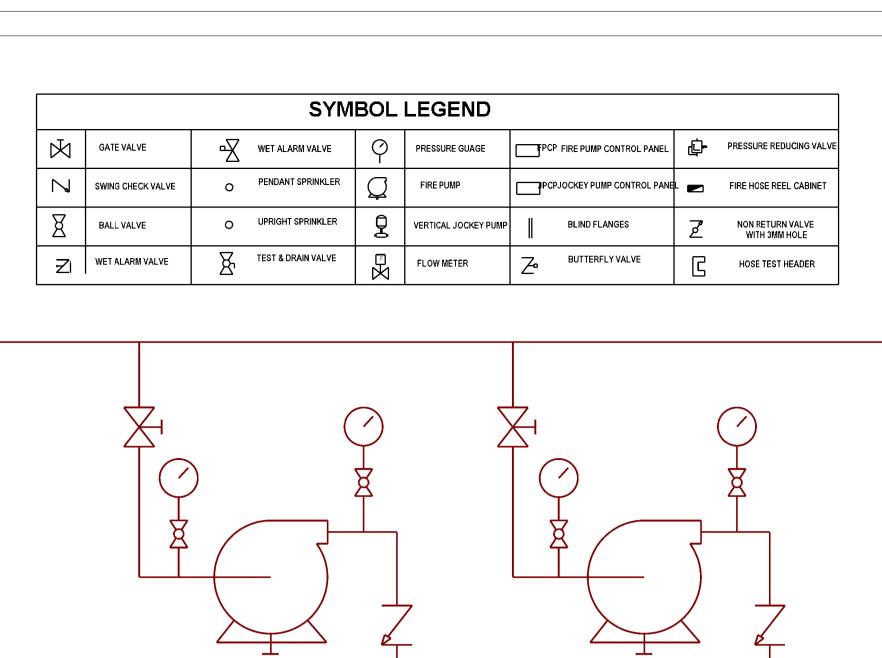

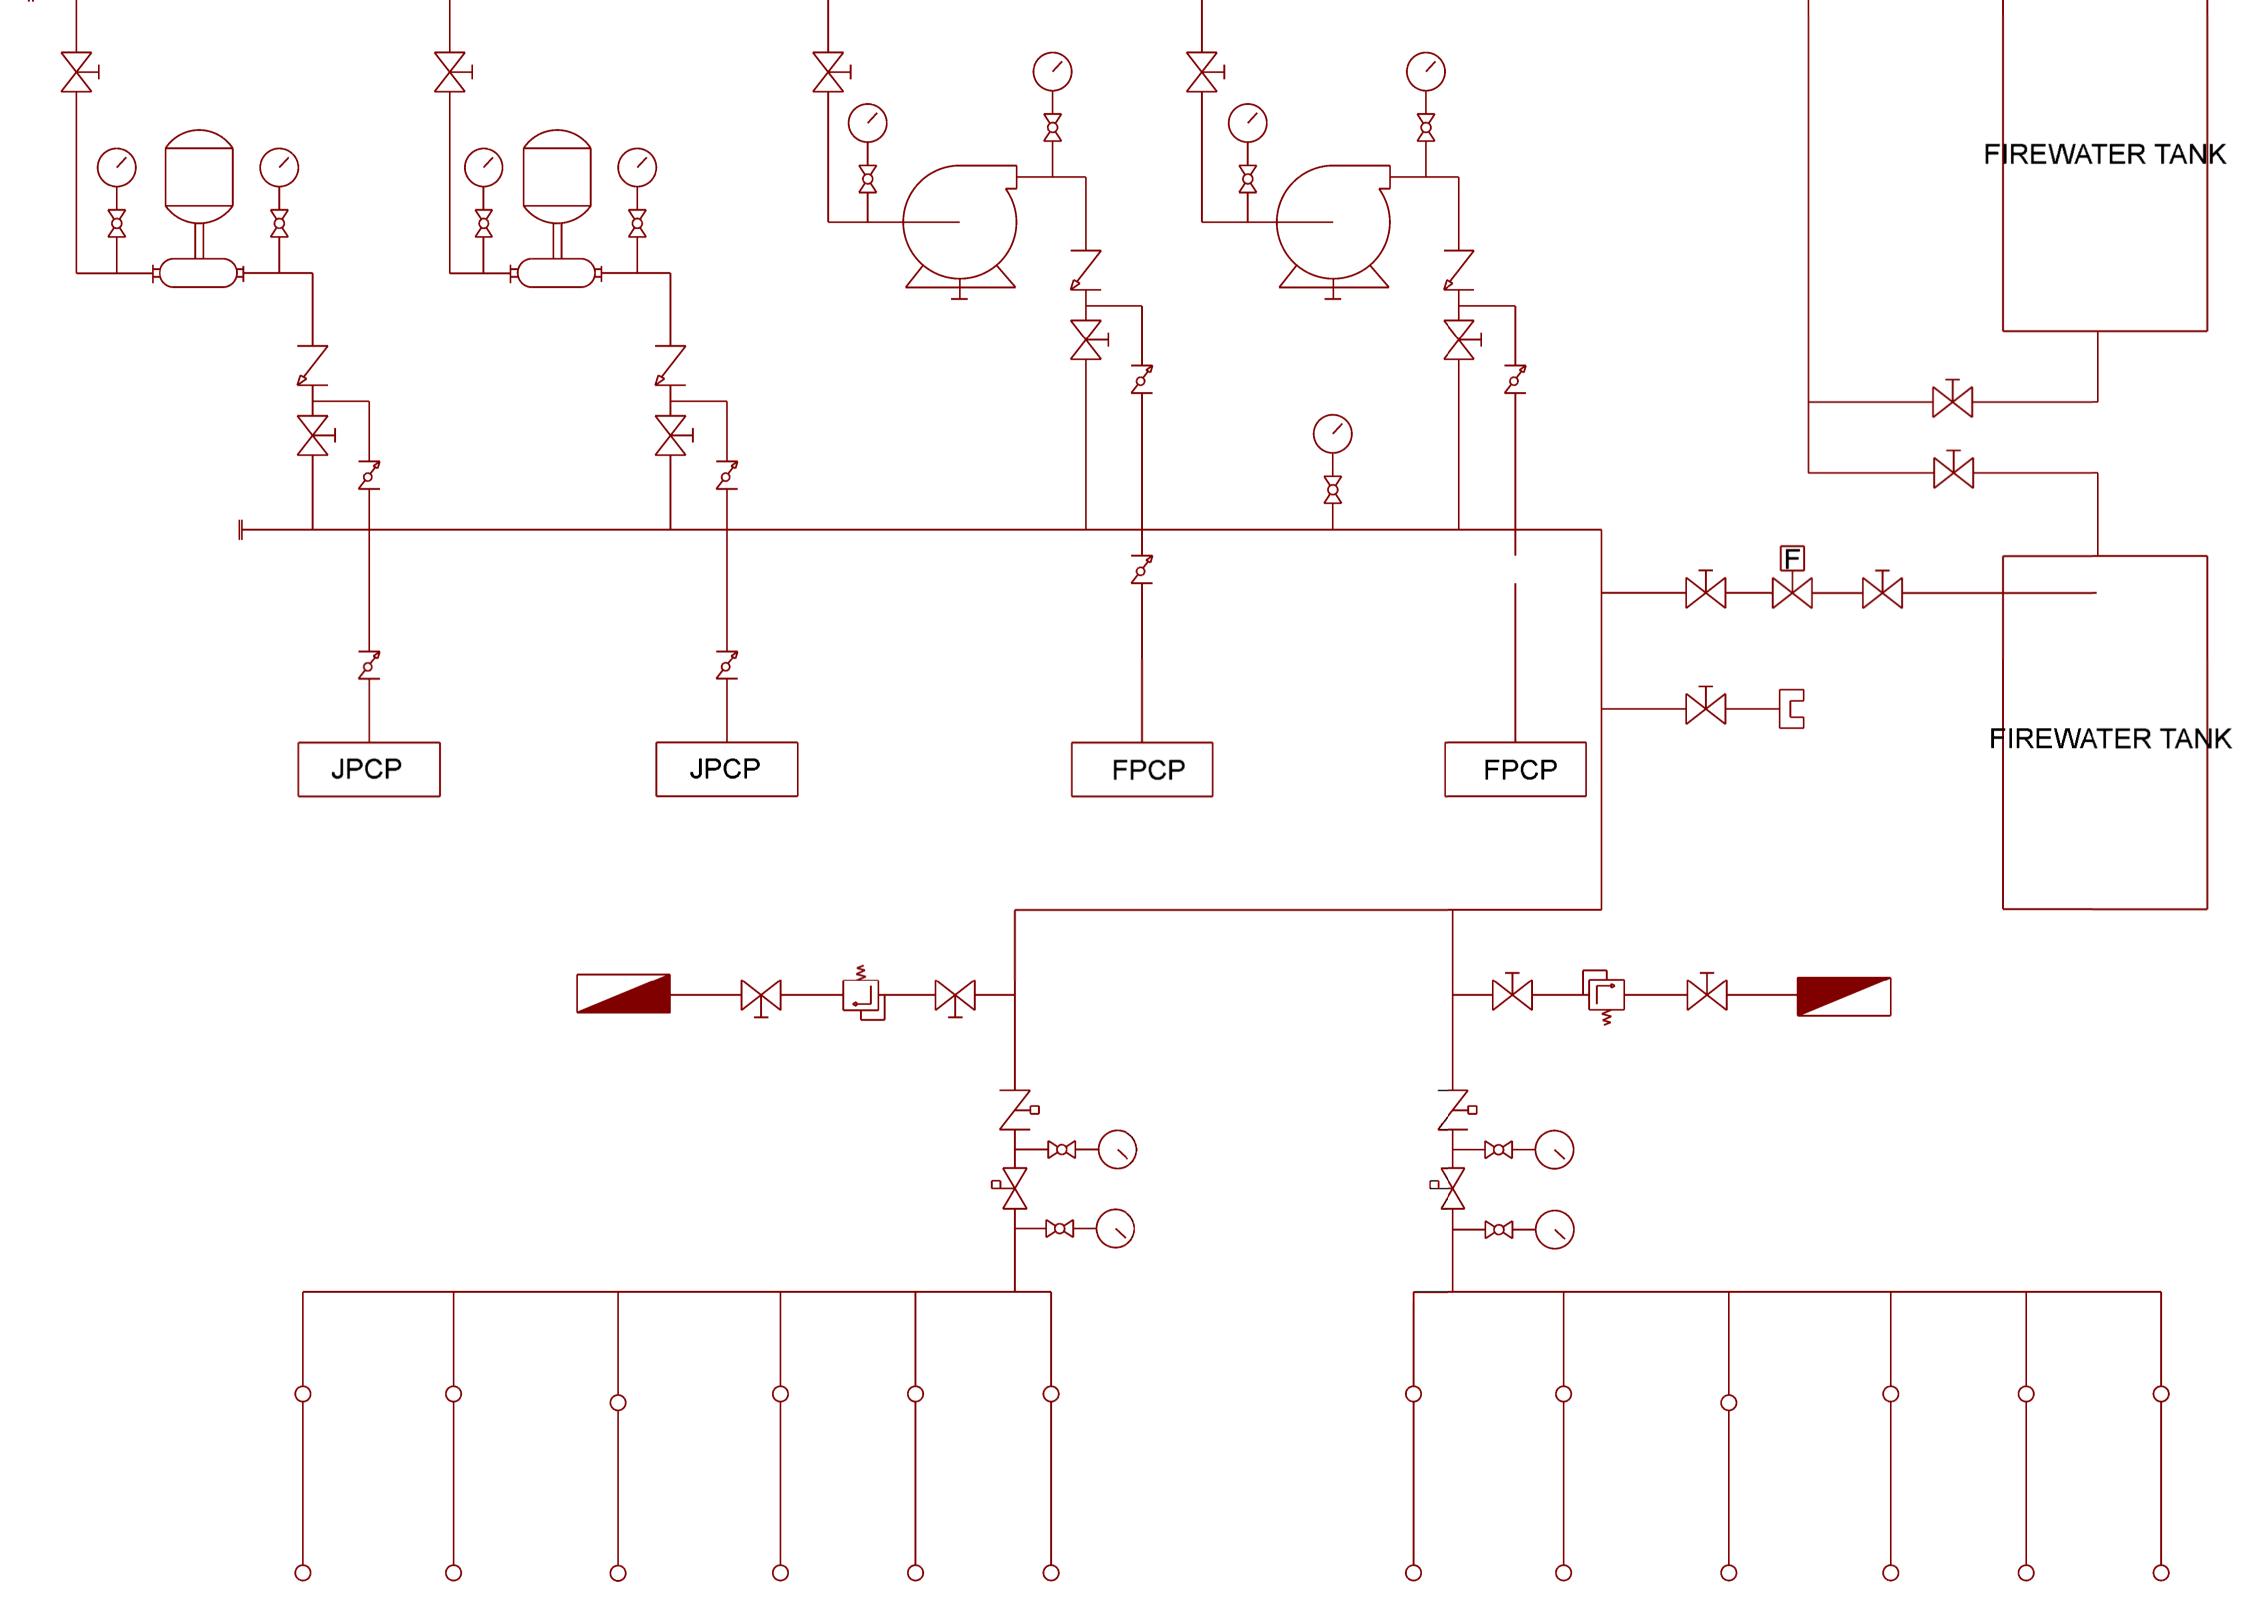

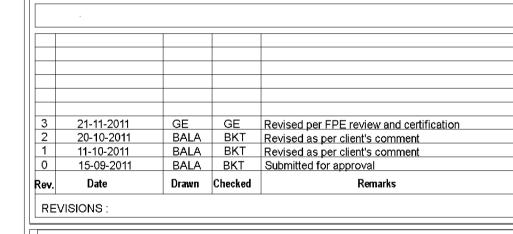

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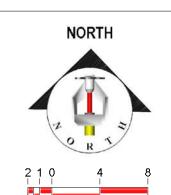
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Standard Symbols -N.R.S. - Key Operated Valve

- Public Hydrant - O.S.&Y. Gate Valve Check Valve - New Underground

- Fire Dept. Connection

Existing Underground

- Thrust Block - Backflow Preventer

Standard Symbols

Standard Sprinkler Symbols

 Upright on ½" Outlet - Pendent on 1/2" Outlet

- Sidewall on 1" Sprig

-Opright on 1" Sprig - Pendent below ceiling on 1" Drop - Upright above Pendent on 1" Drop - Sidewall on ½" Outlet

GENERAL SYSTEM NOTES 1. HYDRAULIC INFORMATION TO BE PROVIDED ON SPRINKLER RISER.

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OUTLETS, ROLL GROOVED/THREADED ENDS WITH GROOVED/THREADED FITTINGS. 6. MAIN PIPING SHALL BE SCH. #40 GALVANIZED WITH WELDED OUTLETS, ROLL GROOVED ENDS, AND GROOVED FITTINGS. 7. SYSTEM DESIGN SHALL BE PER N.F.P.A. #13 8. XX = HYDRAULIC REFRENCE POINT.

Sprinkler Legend Symbol Manufacturer | SIN/Model Quantity | K-Factor | Type | Response | Orifice | Finish | Temperature O |Rapidrop 12 1/2 Brass 93.33 ℃ RD025 80 Upright Quick 80 Pendent Quick 13 1/2 Brass 93.33 ℃ RD023





CERTIFIED BY:

DRAWING TITLE :

GWE Gerald W. Ebeling, S.E.T. CHECKED APRROVED GWE AS NOTED REV. NO. SCALE SHEET:5 OF 6 DRAWING NO.:FP-05

SCHEMATIC

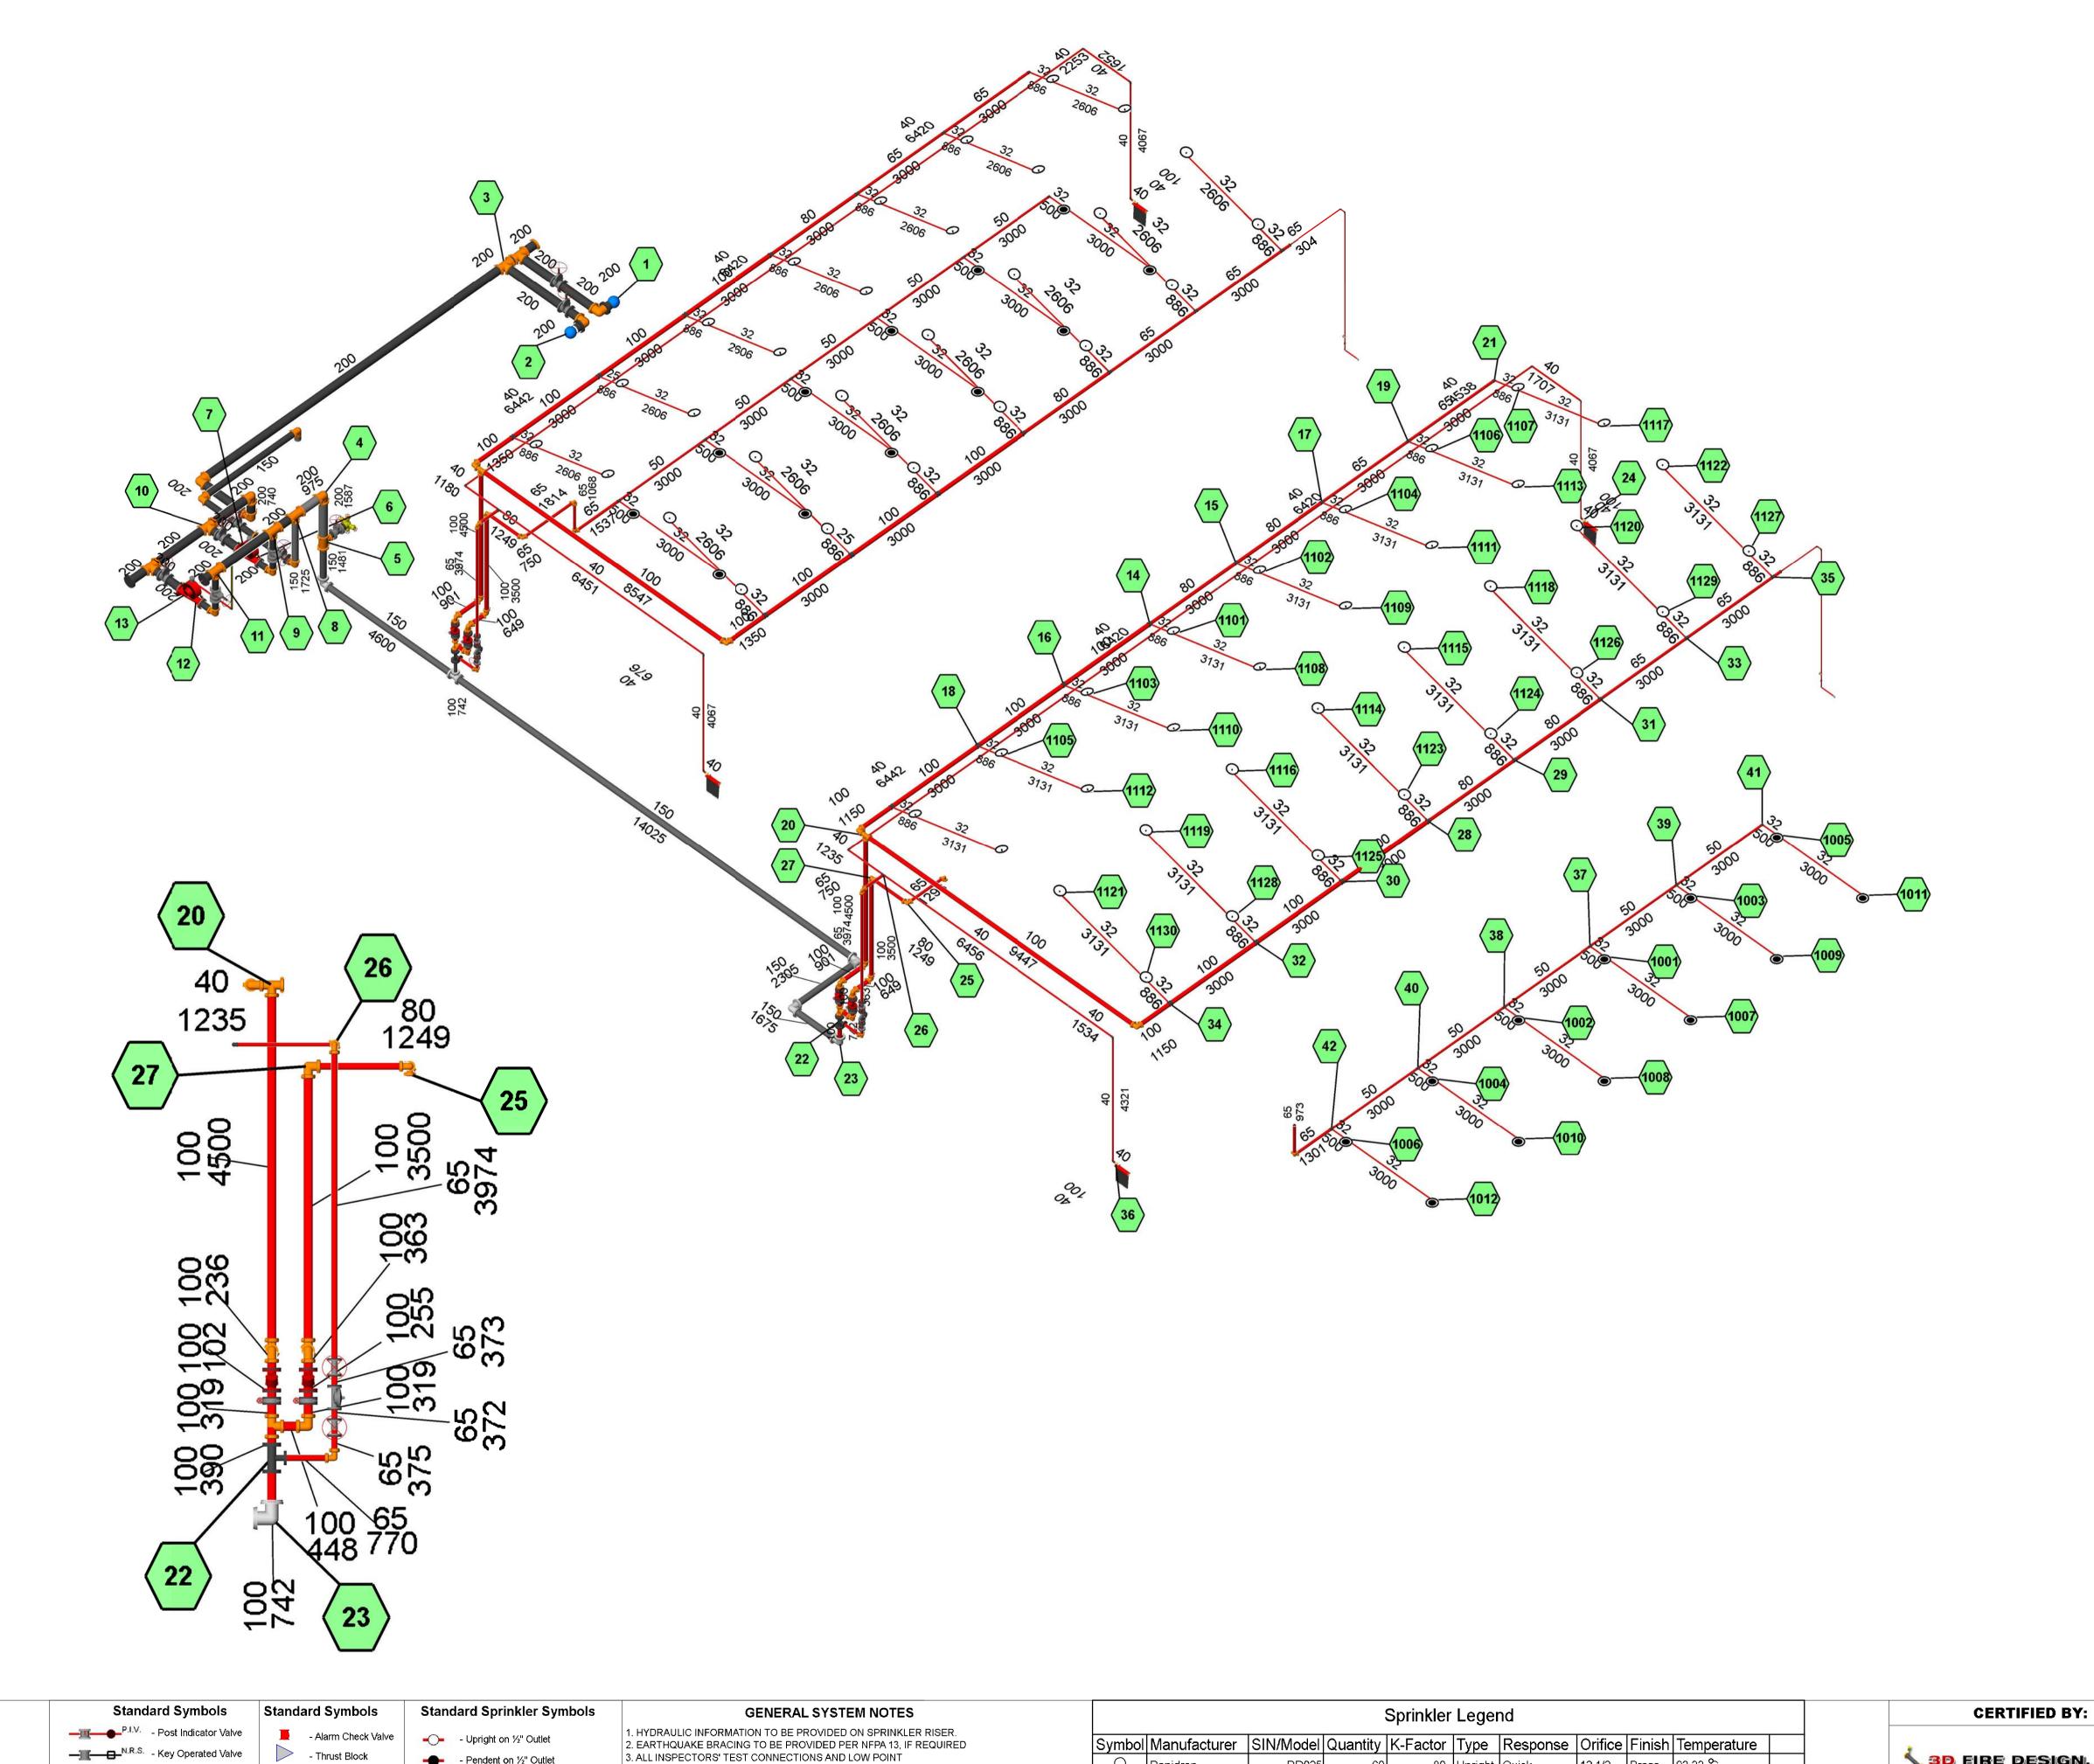

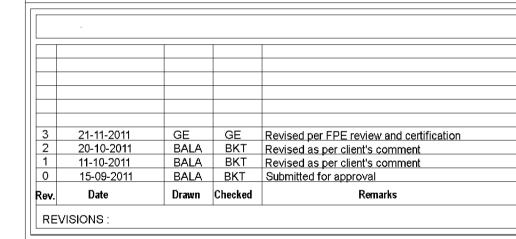

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USACE

MAIN CONTRACTOR:

SCALE

STRABAG OMAN LLC

STRABAG Oman LLC PO Box 444, Muscat Postal Code 100 Sultanate of Oman Tel.: +968-24526900 Fax: +968-24526902

FIRE PROTECTION SYSTEM CONTRACTOR:

DRAWING NO.:HYD CALC SCHEMATIC

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- Public Hydrant - O.S.&Y. Gate Valve

Check Valve

- New Underground

Existing Underground

- Fire Dept. Connection

- Backflow Preventer

-O- - Upright on 1" Sprig

- Sidewall on ½" Outlet


- Sidewall on 1" Sprig

- Pendent on 1/2" Outlet - Pendent below ceiling on 1" Drop - Upright above Pendent on 1" Drop

DRAINS TO BE PROVIDED PER NFPA 13. 4. ALL HANGERS TO MEET CURRENT NFPA 13 REQUIRMENTS (U.N.O.). 5. LINE PIPING SHALL BE SCH. #40 GALVANIZED PIPE WITH WELDED

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DRAWING TITLE : FP6 GWE CHECKED APRROVED GWE

AS NOTED

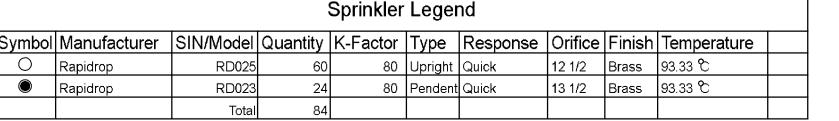SHEET:6 OF 6

REV. NO.